

HOUSE AREAS	
Ground Living Area:	190.70m <sup>2</sup>
First Floor Living Area:	182.53m <sup>2</sup>
Garage:	37.23m <sup>2</sup>
Porch:	4.84m <sup>2</sup>
Alfresco:	22.03m <sup>2</sup>
Total Area:	437.33m <sup>2</sup> 47.02Sq
CDC Gross Floor Area:	359.02m <sup>2</sup>



# Brochure Plan

scale 1:110




Issue	Amendment	Date:	North:
A	Concept Plans	30.06.21	

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Proposed: New Double Storey Dwelling	Drawing Title: Brochure Plan	Revision: <b>A</b>
Location: .	L.G.A	Design: BOLTON 47
Client: Vogue Homes	Facade : Standard Date 30.06.21	VH Job No: TBC
	Scale 1:110 Sheet 1 of 1	JR Job No: VH0000

1. All work to be carried out in accordance with the requirements of the Building Code of Australia and the relevant local authority.  
2. All timber framing to be carried out to the requirements of Australian Standards (as 1884) as a minimum.  
3. All reinforced concrete, steel beams including supports, and nominated beams including supports to Engineer's details.  
4. Structural Engineer to check, detail and certify brickwork to garage area with a height greater than 3000mm between horizontal supports.  
5. All brickwork to be constructed in accordance with the requirements of the Building Code of Australia.  
6. Ceilings to be provided in accordance with the requirements of the Building Code of Australia.  
7. Downway openings with inward opening doors to rooms containing toilets which are closer than 1200mm to the toilet door to be fitted with hinges to allow the door to be removed from the outside when the door is closed.

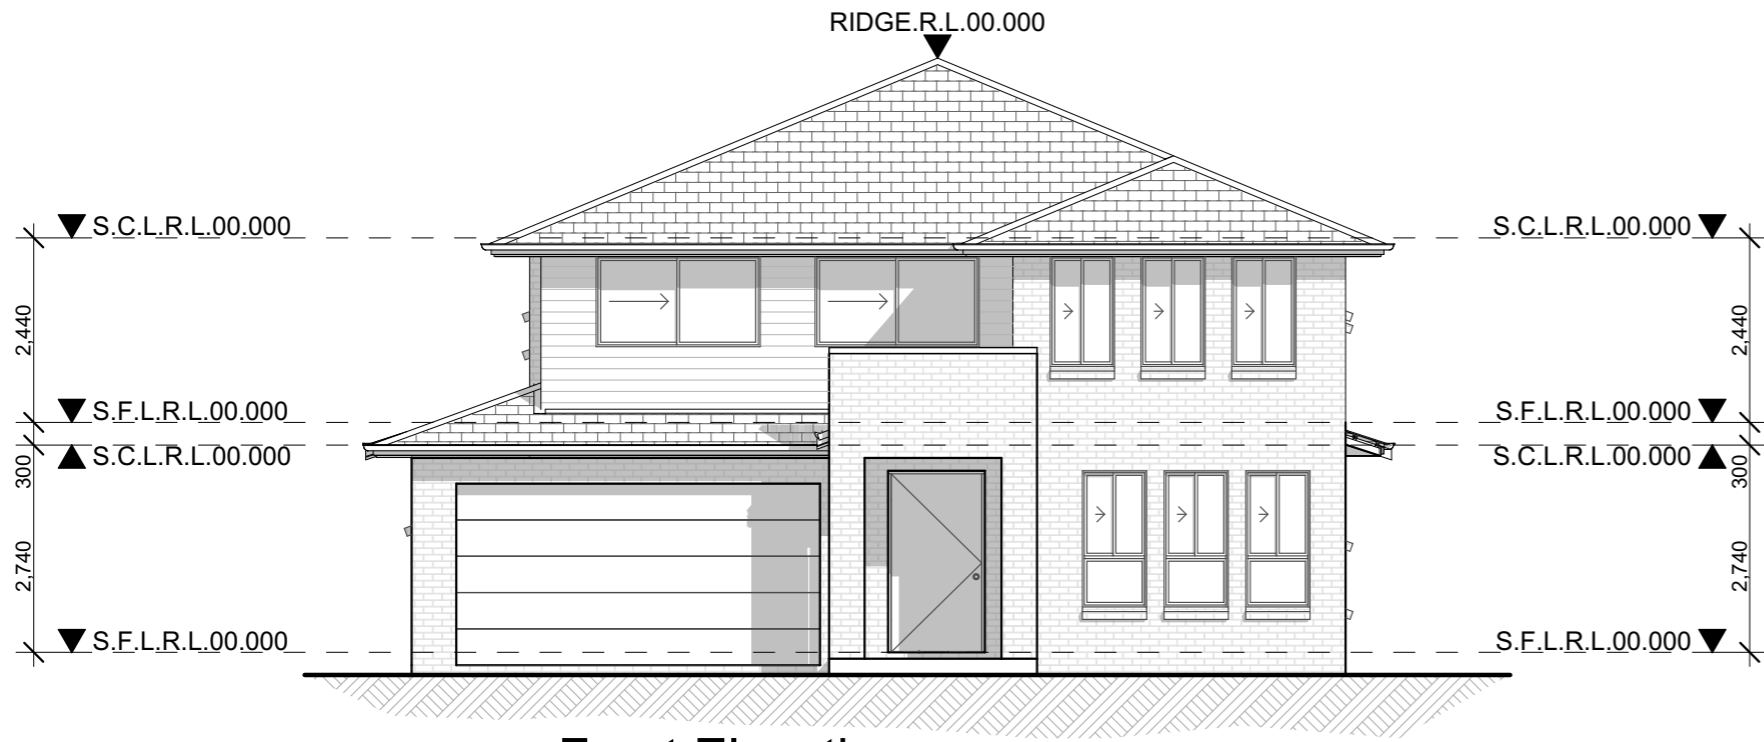

○ Front Elevation  
Elevation 4 scale 1:100

- CONSTRUCTION NOTES:**
1. Figured dimensions are to be taken in preference to scaling
  2. No allowance has been made for shrinkage or milling
  3. All Levels shown are approximate and should be verified on site during construction
  4. Doorway openings with inward opening doors to room containing toilets which are closer than 1200mm to the toilet are to be fitted with hinges to allow the door to be removed from the outside when the door is closed.
  5. Dimensions are to be verified on site by builder before the commencement of work
  6. All timber framing to be carried out to the requirements of Australian Standards (as 1684) as a minimum.
  7. Refer to the builders scope of works for inclusions & exclusions
  8. All work to be carried out in accordance with the requirements of the Building Code of Australia and the relevant local authority.
  9. All service positions, air conditioning droppers, outlets, return air grills, manholes and bulkheads to be determined on site at supervisor / contractors discretion
  10. All reinforced concrete, steel beams including supports, and nominated beams including supports to Engineer's details.
  11. Termite protection in accordance with Australian Standards
  12. Refer to Basix Certificate for energy, water & thermal requirements
  14. All 1st floor windows with a sill height less than 1700mm to have a max opening width of 125mm
  15. Final Construction Joints, steel posts & Beams, Floor Joist to structural engineer plans
  16. Meter Box, Gas Meter to be confirmed with Builder on site.
  17. Downpipes to be confirmed with plumber on site.



○ Side Elevation  
Elevation 1 scale 1:100

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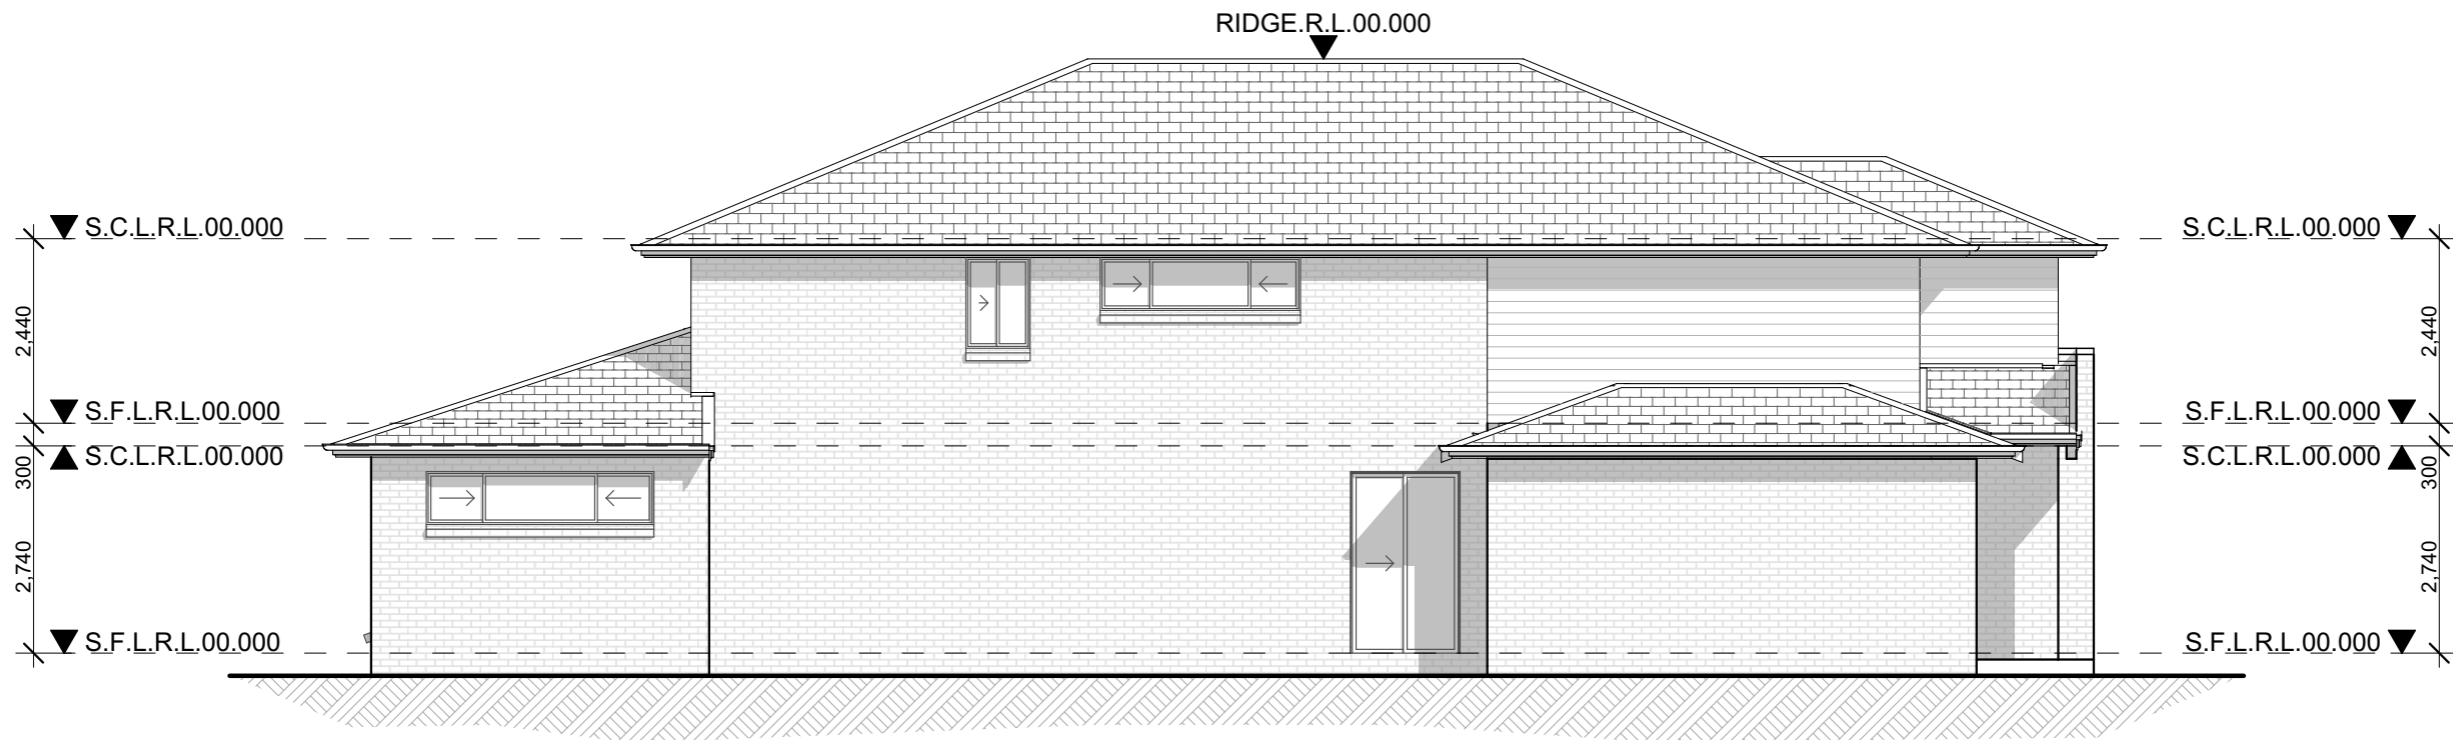
Proposed: New Double Storey Dwelling	Drawing Title: Elevations	Revision: <b>A</b>
Location: .	L.G.A	Design: BOLTON 47
Client: Vogue Homes	Facade : Standard Scale 1:100	VH Job No: TBC
	Date 30.06.21 Sheet 3 of 4	JR Job No: VH0000

1. All work to be carried out in accordance with the requirements of the Building Code of Australia and the relevant local authority.  
2. All timber framing to be carried out to the requirements of Australian Standards (as 1684) as a minimum.  
3. All reinforced concrete, steel beams including supports, and nominated beams including supports to Engineer's details.  
4. Structural Engineer to check, detail and certify brickwork to garage area with a height greater than 3000mm between horizontal supports.  
5. All brickwork to be constructed in accordance with the requirements of the Building Code of Australia.  
6. Coated pipes in brickwork to be provided in accordance with the requirements of the Building Code of Australia.  
7. Doorway openings with inward opening doors to room containing toilets which are closer than 1200mm to the toilet are to be fitted with hinges to allow the door to be removed from the outside when the door is closed.



**Rear Elevation**  
Elevation 2 scale 1:100

- CONSTRUCTION NOTES:**
1. Figured dimensions are to be taken in preference to scaling
  2. No allowance has been made for shrinkage or milling
  3. All Levels shown are approximate and should be verified on site during construction
  4. Doorway openings with inward opening doors to room containing toilets which are closer than 1200mm to the toilet are to be fitted with hinges to allow the door to be removed from the outside when the door is closed.
  5. Dimensions are to be verified on site by builder before the commencement of work
  6. All timber framing to be carried out to the requirements of Australian Standards (as 1684) as a minimum.
  7. Refer to the builders scope of works for inclusions & exclusions
  8. All work to be carried out in accordance with the requirements of the Building Code of Australia and the relevant local authority.
  9. All service positions, air conditioning droppers, outlets, return air grills, manholes and bulkheads to be determined on site at supervisor / contractors discretion
  10. All reinforced concrete, steel beams including supports, and nominated beams including supports to Engineer's details.
  11. Termite protection in accordance with Australian Standards
  12. Refer to Basix Certificate for energy, water & thermal requirements
  14. All 1st floor windows with a sill height less than 1700mm to have a max opening width of 125mm
  15. Final Construction Joints, steel posts & Beams, Floor Joist to structural engineer plans
  16. Meter Box, Gas Meter to be confirmed with Builder on site.
  17. Downpipes to be confirmed with plumber on site.



**Side Elevation**  
Elevation 3 scale 1:100

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Proposed: New Double Storey Dwelling	Drawing Title: Elevations	Revision: <b>A</b>
Location: .	L.G.A	Design: BOLTON 47
Client: Vogue Homes	Facade : Standard Scale 1:100	VH Job No: TBC
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1. All work to be carried out in accordance with the requirements of the Building Code of Australia and the relevant local authority.  
2. All timber framing to be carried out to the requirements of Australian Standards (as 1684) as a minimum.  
3. All reinforced concrete, steel beams including supports, and nominated beams including supports to Engineer's details.  
4. Structural Engineer to check, detail and certify brickwork to garage area with a height greater than 3000mm between horizontal supports.  
5. All brickwork to be constructed in accordance with the requirements of the Building Code of Australia.  
6. Corbel girders to brickwork to be provided in accordance with the requirements of the Building Code of Australia.  
7. Doorway openings with inward opening doors to room containing toilets which are closer than 1200mm to the toilet are to be fitted with hinges to allow the door to be removed from the outside when the door is closed.